**CIVIL ENGINEER** SUSTAINABILITY ENGINEERING GROUP 8280 E. GELDING DR, SUITE 101 PHONE: 480-237-2507 ATTN. ALI FAKIH

L=47.07', R=29.99'

IE=27.03 (18")(NE)

IE=27.05 (18")(SE) IE=26.93 (18")(W)

21 LF (18") 5A S=1.11%

DRO

EX. 48" RCP

STORM DRAIN

FOUND REBAR WITH

ALUMINUM CAP "CITY OF

SEWER LINE

WATER LINE

WATER VALVE

FIRE HYDRANT

 $\equiv$  CURB AND GUTTER

SEWER MANHOLE

ALBUQUERQUE ALAMEDA

BLVD. ROW 2014 224

NMPS 11599" —

—— EX. W ——

 $\mathbb{W}\mathbb{V} \otimes$ 

RIM=31.44

IE=27.80 (18")(NE)

D=89°55'13"


 $\frac{CB-1}{RIM=31.64}$ 


TE=27.56 (18")(SW

**OWNER** GREEN JEANS WEST, LLC 2929 MONTE VISTA NE ALBUQUERQUE, NM 87106

## WHATABURGER **GRADING AND DRAINAGE PLAN**

6100 ALAMEDA BLVD NE, ALBUQUERQUE, NM A PORTION OF SECTION 13, TOWNSHIP 11 NORTH, RANGE 3 EAST BERNALILLO COUNTY, NEW MEXICO.

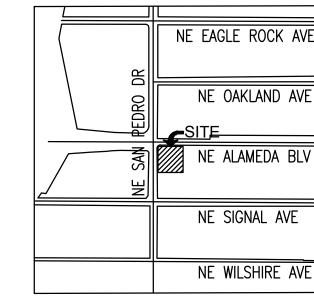

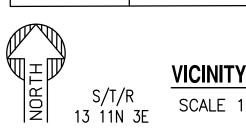

# **VICINITY MAP**

### GRADING CONSTRUCTION KEY NOTES

- MATCH EXISTING GRADE; CONTRACTOR TO VERIFY IN FIELD ALL GRADES PRIOR TO CONSTRUCTION ACTIVITIES AND CONTACT ENGINEER IN CASE OF ANY DISCREPANCIES.
- (2A) CONSTRUCT 6" VERTICAL CURB AND GUTTER PER COA STD DWG 2415-A.
- (3A) CONSTRUCT ADA RAMP. PER DET. 11/C3.11.
- (3C) CONSTRUCT ADA RAMP. PER DET. 12/C3.11.
- 5 FURNISH AND INSTALL HDPE DOUBLE WALL PIPE, CLASS 100; LENGTH, SIZE AND SLOPE PER

- (8) FURNISH AND INSTALL 4' MANHOLE PER COA DETAIL 2208.
- (9) CONSTRUCT CONCRETE SIDEWALK PER COA STD DWG 2430. WIDTH PER PLAN.
- (10) CONSTRUCT PAVEMENT WITH 2% MAXIMUM SLOPE IN ANY DIRECTION AT ACCESSIBLE PARKING STALLS AND 2% MAXIMUM CROSS SLOPE AT ADA ACCESSIBLE ROUTE.

- (14) TRANSITION TO EXISTING PAVEMENT PER DET. 1/C3.10.
- (15) SAWCUT, REMOVE AND REPLACE EXISTING PAVEMENT.
- (16) CONSTRUCT 3' CURB OPENING. PER DET. 3/C3.10.
- (17) TURN DOWN SIDEWALK. PER DET. 9/C3.10.
- (18) TURN DOWN SIDEWALK. PER DET. 16/C3.11.

GRADING AND DRAINAGE PLAN

SCALE: 1" = 20'

- A.G.R.S. MONUMENT "9 $\_$ C18"

(CENTRAL ZONE-N.A.D. 1983)

(FOUND IN PLACE)

(NAVD 1988)

CONCRETE PAVEMENT

STORM INLET

HEAVY DUTY PAVEMENT

STANDARD C.O.A. ALUMINUM DISC

N=1,521,497.624 US SURVEY FEET

E= 1,542,501.428 US SURVEY FEET

DELTA ALPHA ANGLE=-0°11'19.69"

NEW MEXICO STATE PLANE COORDINATES

PLUBLISHED EL=5232.47 US SURVEY FEET

GROUND TO GRID FACTOR=0.999664563

(19) 5' CURB TRANSITION FROM 6" TO 0" REVEAL.

THE EXISTING SITE IS PARTIALLY DEVELOPED. THE SOUTHERN PORTION OF THE PROPERTY INCLUDES A EXISTING DRAINAGE POND, DIRT PILES AND STORAGE CONTAINER. DRAINAGE STRUCTURES, SEWER AND WATER LINES, AND DRY UTILITIES SUCH AS POWER, GAS AND ELECTRICITY EXIST WITHIN THE SITE. LOT

THE PROJECT WILL CONSIST IN THE DEMOLITION OF MOST OF THE EXISTING SOUTH PARKING LOT AND THE CONSTRUCTION OF A FAST FOOD RESTAURANT (2,999 SF) WITH A DRIVE-THRU, PARKING AREA,

- (2) CONSTRUCT 6" HEADER CURB PER COA STD. DET. 2415C
- (3) CONSTRUCT ADA RAMP. PER DET. 10/C3.11.
- (3B) CONSTRUCT DELIVERY RAMP PER DET. 2/C3.10.
- FURNISH AND INSTALL NYLOPLAST DRAIN BASIN WITH 30" RISER AND 2'X3' STEEL GRATE PER DET. 14/C3.20
- 5A FURNISH AND INSTALL REINFORCED CLASS III CONCRETE PIPE, LENGTH, SIZE AND SLOPE PER
- (6) FURNISH AND INSTALL 30" NYLOPLAST DRAIN BASIN WITH SOLID LID. PER DET. 13/C3.12.
- $\overline{7}$  CONSTRUCT HEAVY DUTY PAVEMENT PER DETAIL 5/C3.10.
- (11) CONSTRUCT CONCRETE PAVEMENT PER DETAIL 6/C3.10.
- (12) CAUTION! PROTECT EXISTING GAS AND POWER UTILITIES.
- (13) PAVING TRANSITION PER DET. 7/C3.10.

INVERT ELEVATIONS TO BE VERIFIED IN FIELD.

EXISTING CONDITIONS AND PROPOSED DEVELOPMENT: PARKING LOT WITH LANDSCAPE ISLANDS WHILE THE NORTH AREA REMAINS UNDEVELOPED WITH AN ELEVATION DROP FROM 1,238' AT THE EAST PROPERTY LINE TO ABOUT 1,232' AT THE WEST PROPERTY LINE.

AND DESIGNATED LANDSCAPE.

**DEVELOPER** WHATABRANDS REAL ESTATE CONTACT: CINDY ESPINOZA 300 CONCORD PLAZA DRIVE SAN ANTONIO, TX 78216 PHONE: 210-476-6180

EMAIL: CESPINOZA@WBHQ.COM

)STORM DRAIN

<sup>⊥</sup>S=2.00%

RIM: 31.87

ALBUQUERQUE ACRES

(04/24/1936, D-130)

STORM DRAIN LINE

STORM MANHOLE

GAS LINE

FENCE

STORM CATCH BASIN

LIMIT OF ONSITE

CONSTRUCTION

FLOW ARROW

STORM PIPE

ALAMEDA BOULEVARD, N.E.

 $\frac{TC=33.48}{C=32.98}$ 

N89° 44' 24"W

MONUMENT "10\_C18"

(FOUND IN PLACE)

(NAVD 1988)

STREET LIGHT

ROAD CENTERLINE

STANDARD C.O.A. ALUMINUM DISC

(CENTRAL ZONE-N.A.D. 1983)

N=1,524,123.885 US SURVEY FEET

E= 1,542,565.263 US SURVEY FEET

NEW MEXICO STATE PLANE COORDINATES

PLUBLISHED EL=5222.09 US SURVEY FEET

GROUND TO GRID FACTOR=0.999665042

DELTA ALPHA ANGLE=-0°11'19.42" ----

STORM MANHOLE

WATER METER

GATE VALVE

FIRE HYDRANT

REFEER TO SHEET C3.01 FOR OFF-SITE GRADING

IMPROVEMENTS -

**EXISTING LEGEND:** 

G=XX.XX-

P=XX.XX-

C=XX.XX-

--- XXXX--- EX. MAJOR CONTOURS

-- XXXX--- EX. MINOR CONTOURS

— — — EASEMENT LINE AS NOTED

PROPOSED GRADING LEGEND

EX. SPOT ELEVATION

GUTTER ELEVATION,

PAVEMENT ELEVATION

CONCRETE ELEVATION

TC = G+0.5'

01/18/2022 FINAL QC ----PROJ. MGR. — AF 01/21/2022

CALL NM ONE-CALL

SYSTEM SEVEN (7) DAYS

PRIOR TO ANY EXCAVATION

NOT FOR

CONSTRUCTION

SUSTAINABILITY ENGINEERING GROUP

01/21/2022 ISSUED FOR: DRB

DRAWN

REVISION NO .: DATE:

210907

**GRADING AND DRAINAGE PLAN** 

7 OF 11

C3.00

**DEVELOPER** WHATABRANDS REAL ESTATE CONTACT: CINDY ESPINOZA 300 CONCORD PLAZA DRIVE SAN ANTONIO, TX 78216 PHONE: 210-476-6180

EMAIL: CESPINOZA@WBHQ.COM

CONCRETE ELEVATION

STORM PIPE

C=XX.XX-


**CIVIL ENGINEER** SUSTAINABILITY ENGINEERING GROUP 8280 E. GELDING DR, SUITE 101 SCOTTSDALE, ARIZONA 85260 PHONE: 480-237-2507 ATTN. ALI FAKIH


**OWNER** GREEN JEANS WEST, LLC 2929 MONTE VISTA NE ALBUQUERQUE, NM 87106

# WHATABURGER

### OFF-SITE GRADING AND DRAINAGE PLAN

6100 ALAMEDA BLVD NE, ALBUQUERQUE, NM A PORTION OF SECTION 13, TOWNSHIP 11 NORTH, RANGE 3 EAST BERNALILLO COUNTY, NEW MEXICO.

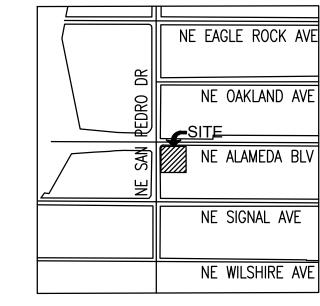


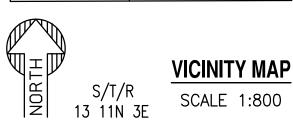

### GRADING CONSTRUCTION KEY NOTES

- MATCH EXISTING GRADE; CONTRACTOR TO VERIFY IN FIELD ALL GRADES PRIOR TO CONSTRUCTION ACTIVITIES AND CONTACT ENGINEER IN CASE OF ANY DISCREPANCIES.
- (2) REMOVE AND REPLACE 6" VERTICAL CURB AND GUTTER PER COA STD DWG 2415-A.
- REMOVE AND REPLACE EXISTING SIDEWALK AS REQUIRED FOR UTILITY CONSTRUCTION. REMOVE TO NEAREST JOINT.
- 4 FURNISH AND INSTALL REINFORCED CLASS III CONCRETE PIPE, LENGTH, SIZE AND SLOPE PER
- (5) SAWCUT, REMOVE AND REPLACE ASPHALT AS NEEDED. PAVEMENT TO MATCH EXISTING SECTION.
- 6 CONSTRUCT CONCRETE SIDEWALK PER COA STD DWG 2430. WIDTH PER PLAN.
- (7) INSTALL PUBLIC STORM INLET TYPE DBL A-SGL WING. PER COA STD DWG 2201.

INVERT ELEVATIONS TO BE VERIFIED IN FIELD.

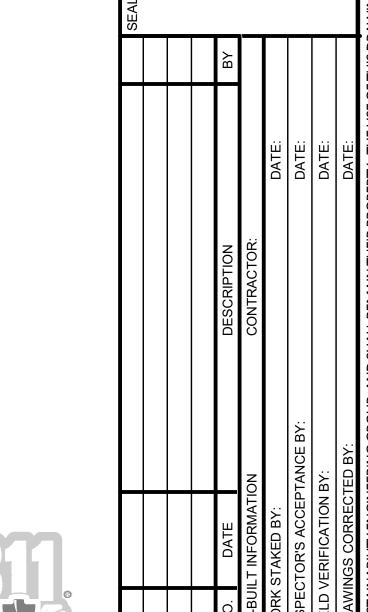

SUSTAINABILITY | ENGINEERING | GROUP



CALL NM ONE-CALL SYSTEM SEVEN (7) DAYS PRIOR TO ANY EXCAVATION

CHECKED BY: SC 12/2021 CITY OF ALBUQUERQUE DEPARTMENT OF MUNICIPAL DEVELOPMENT


DRB




ENGINEERING DIVISION


OFF-SITE GRADING & DRAINAGE


DESIGN REVIEW COMMITTEE CITY ENGINEER APPROVAL ZONE MAP NO. **Z-99** CITY PROJECT NO. 000000 SHEET NO. C3.01

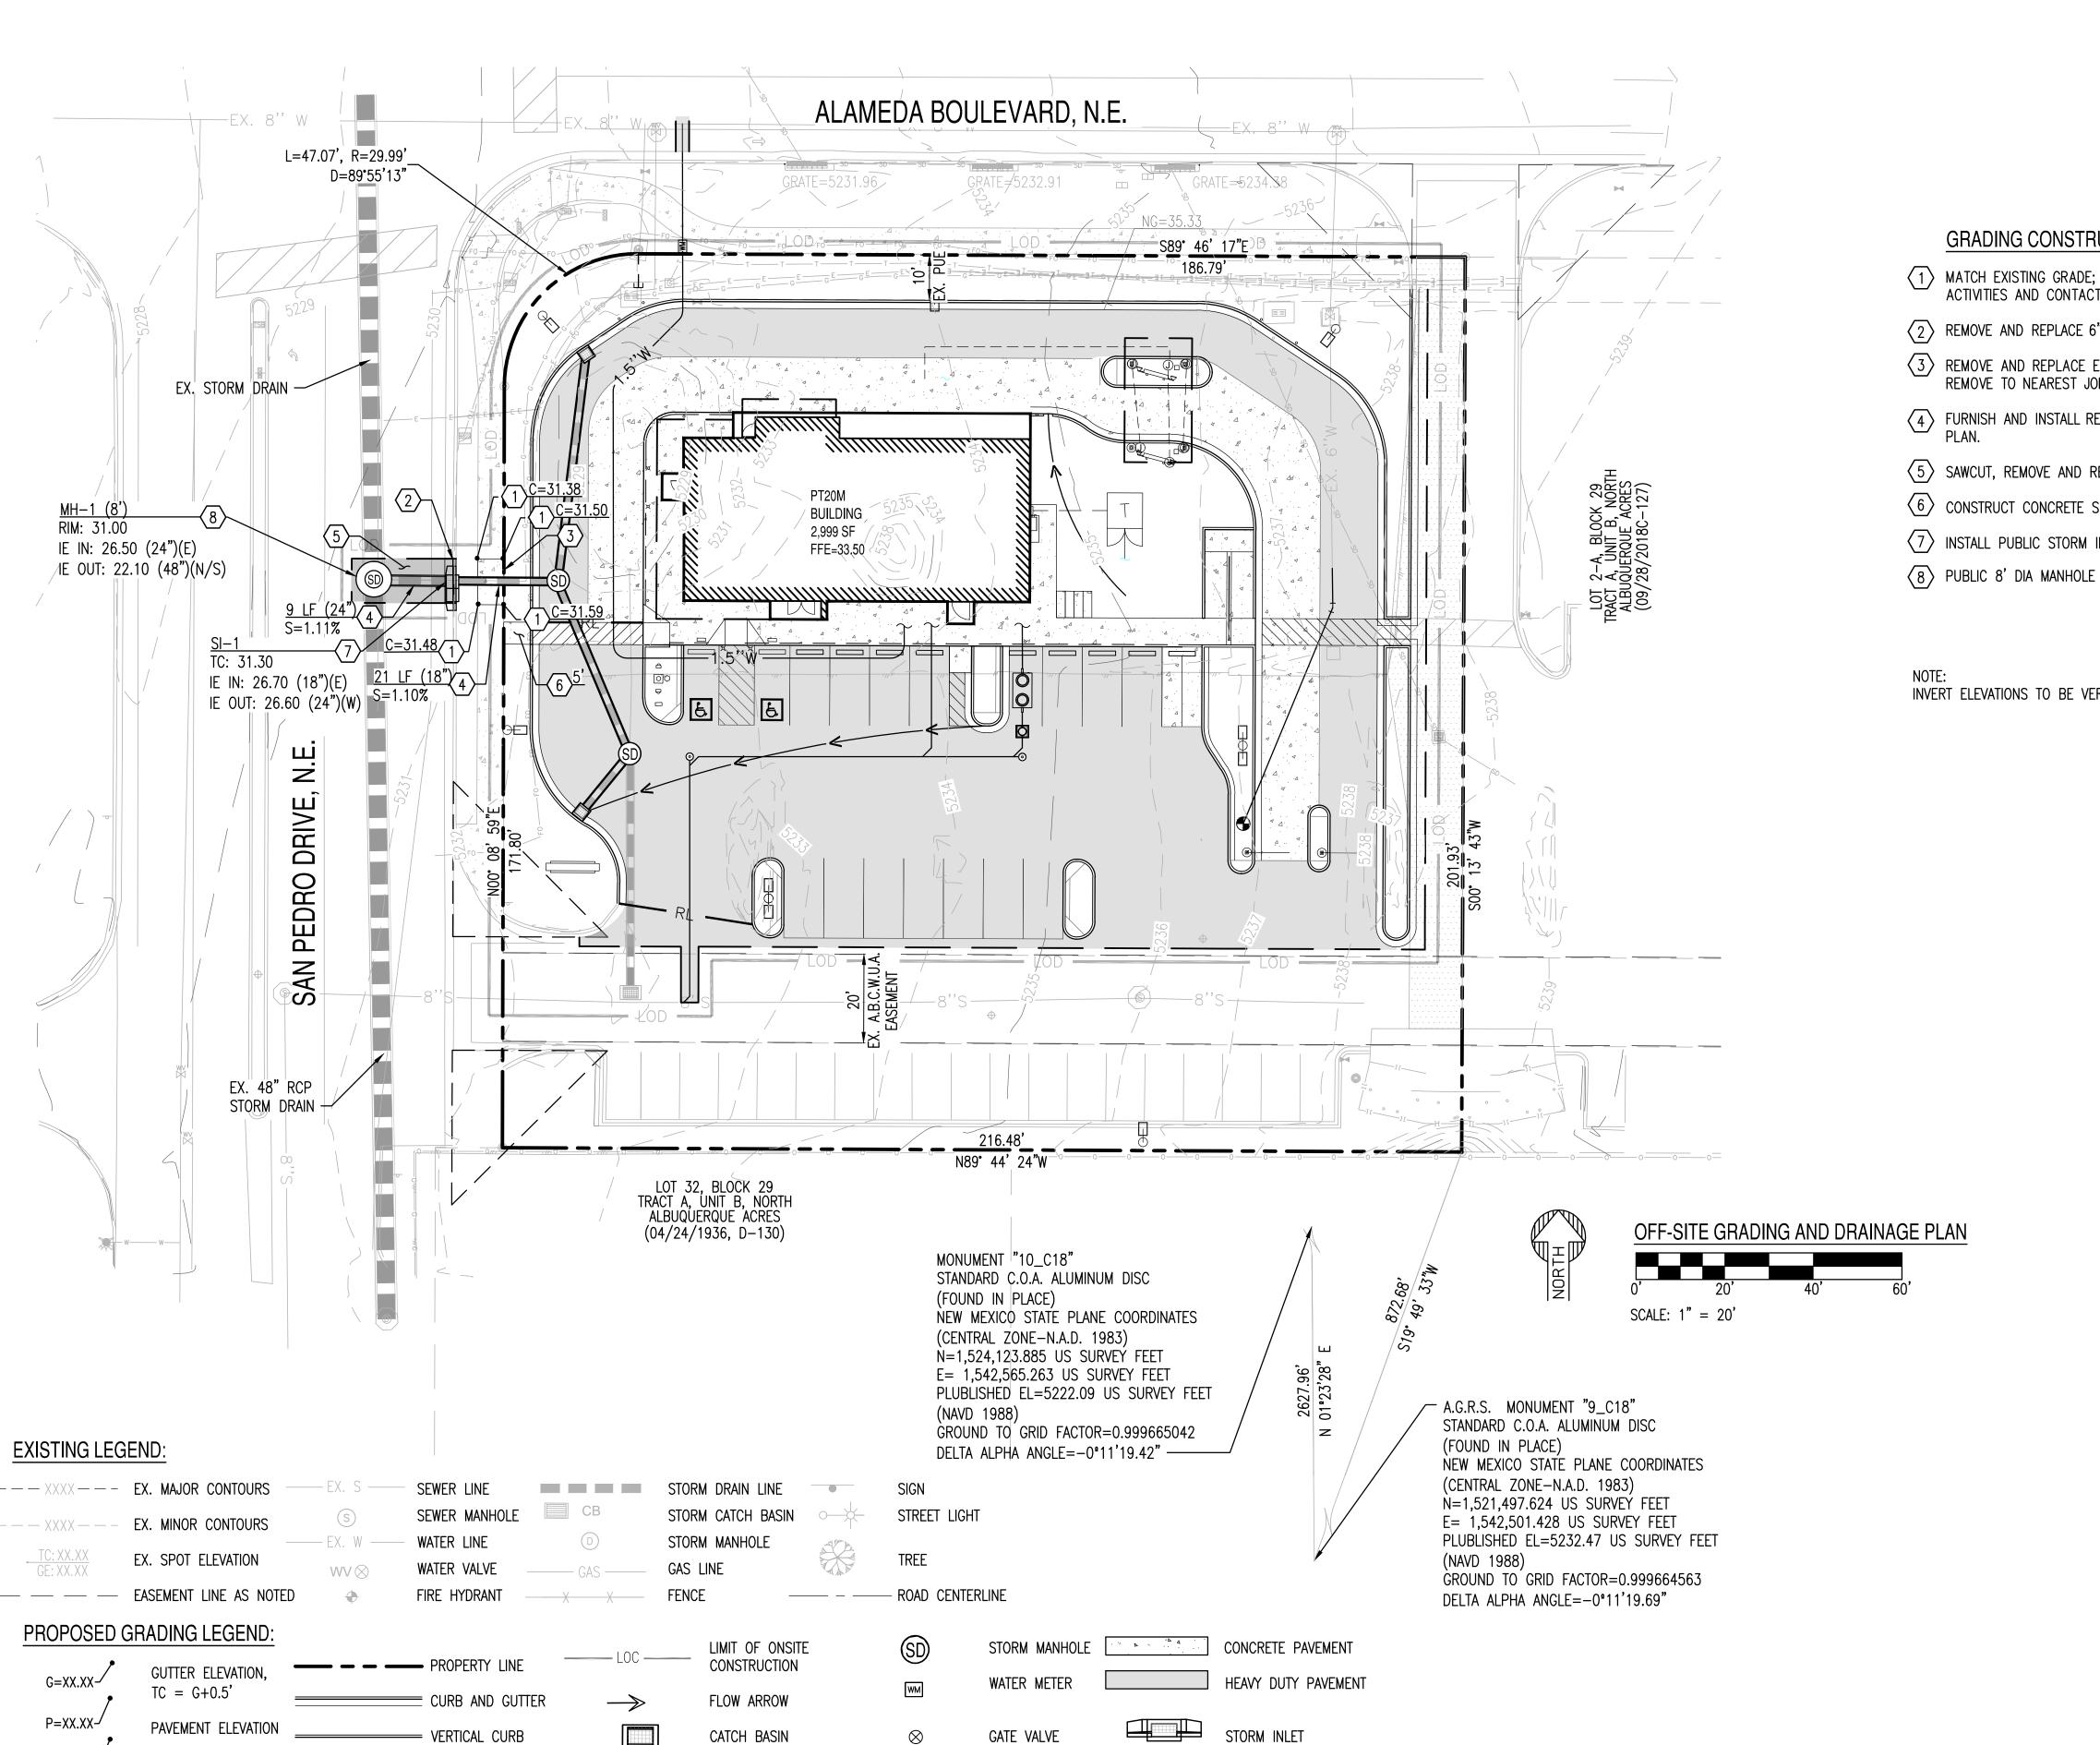

FIRE HYDRANT

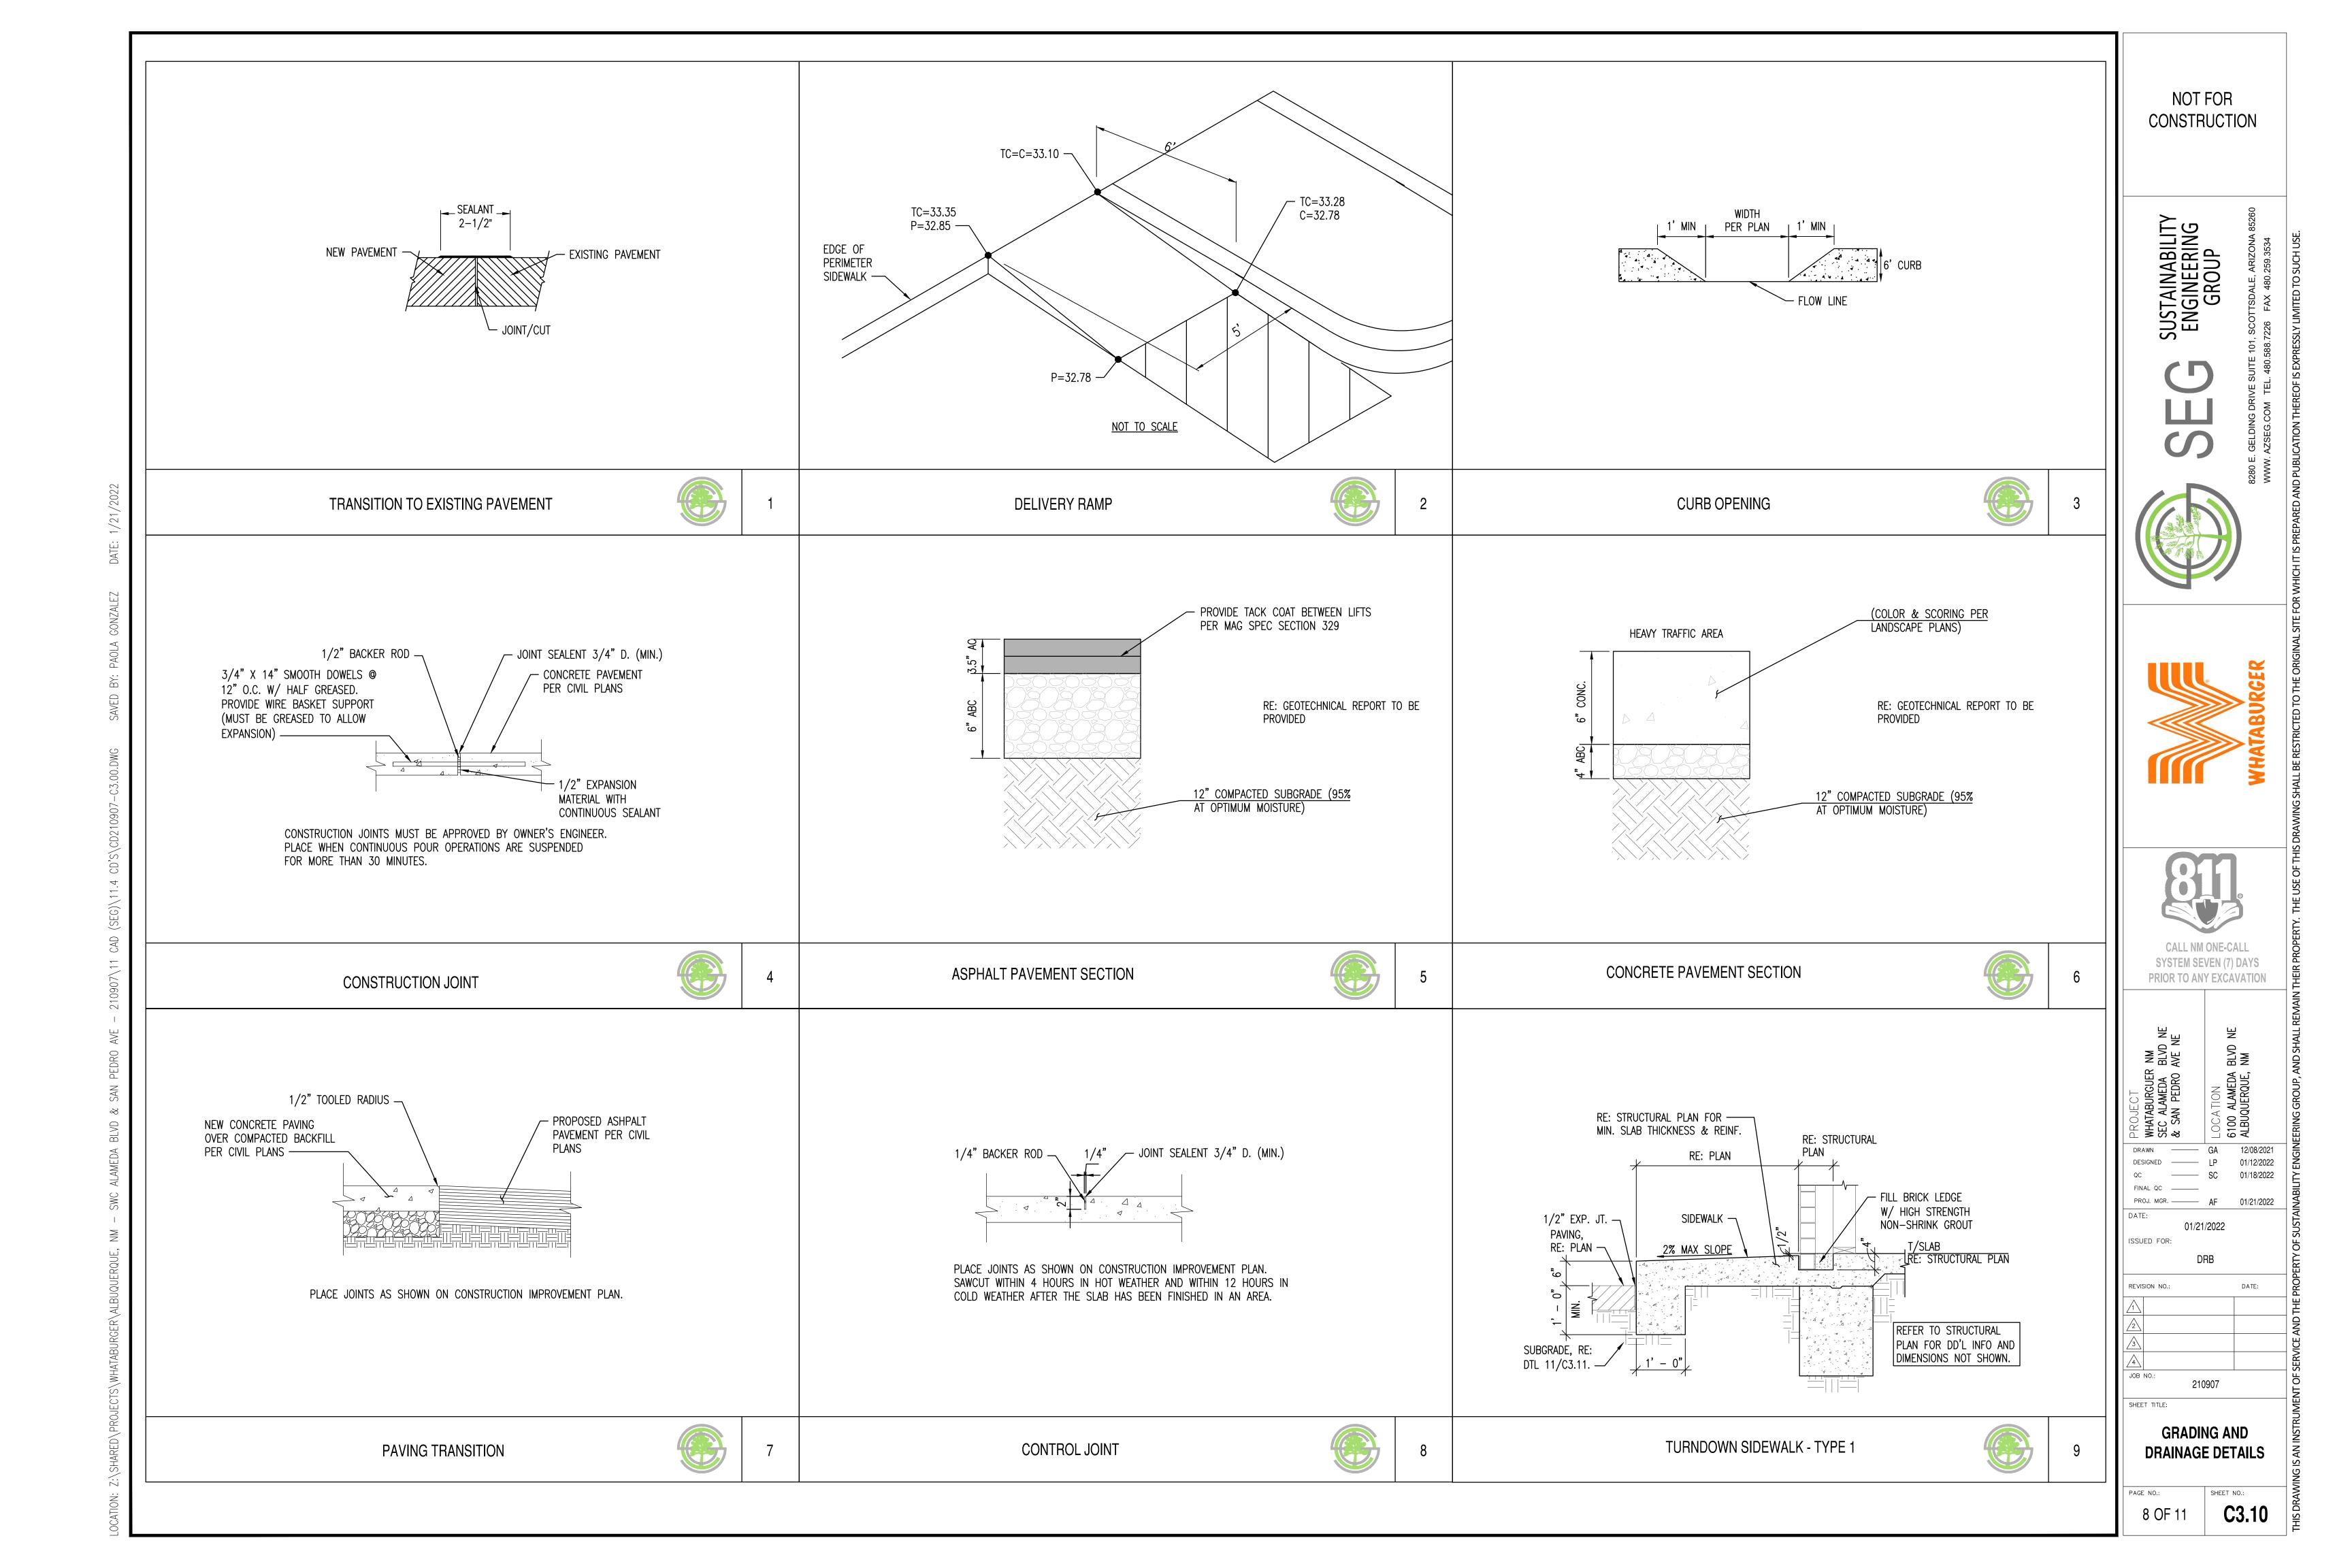

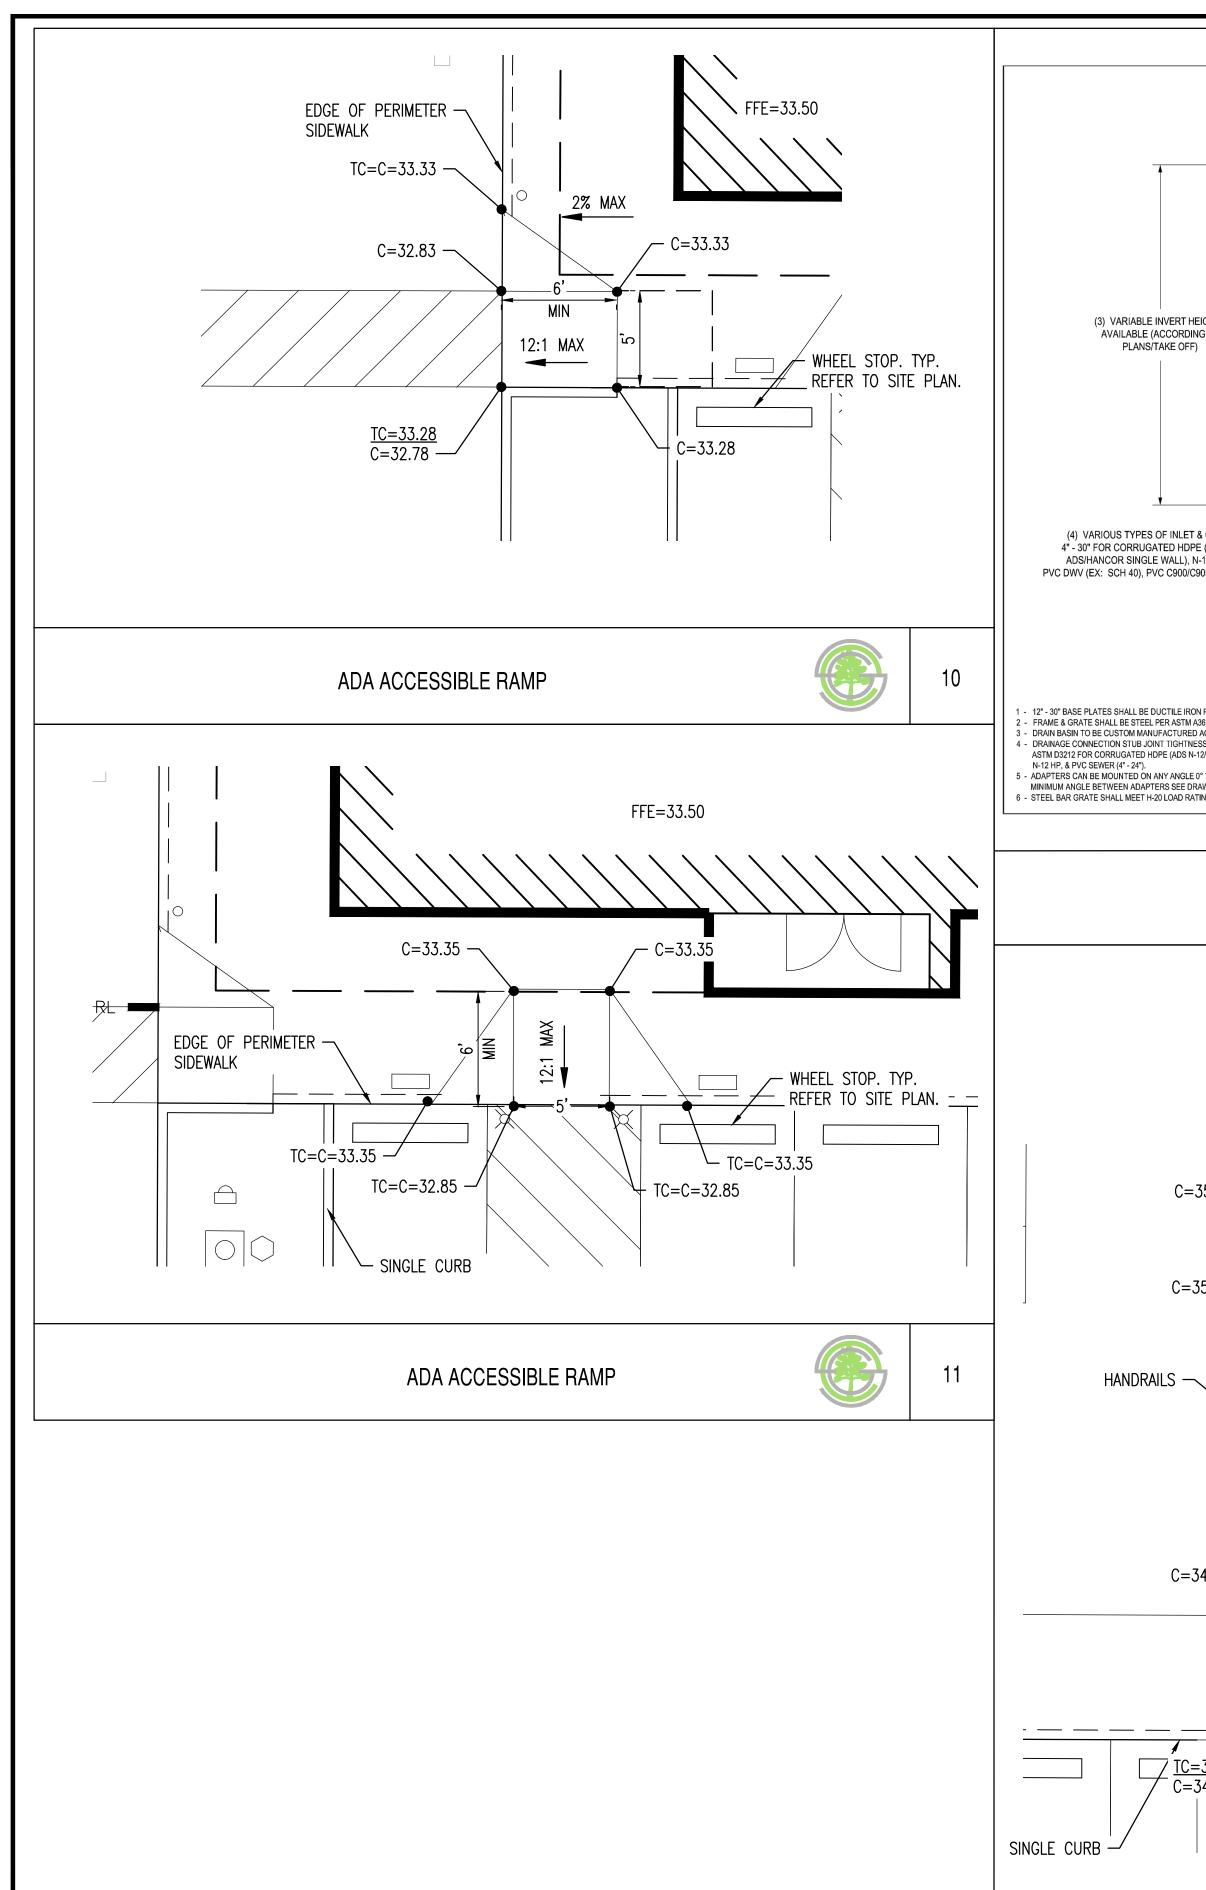

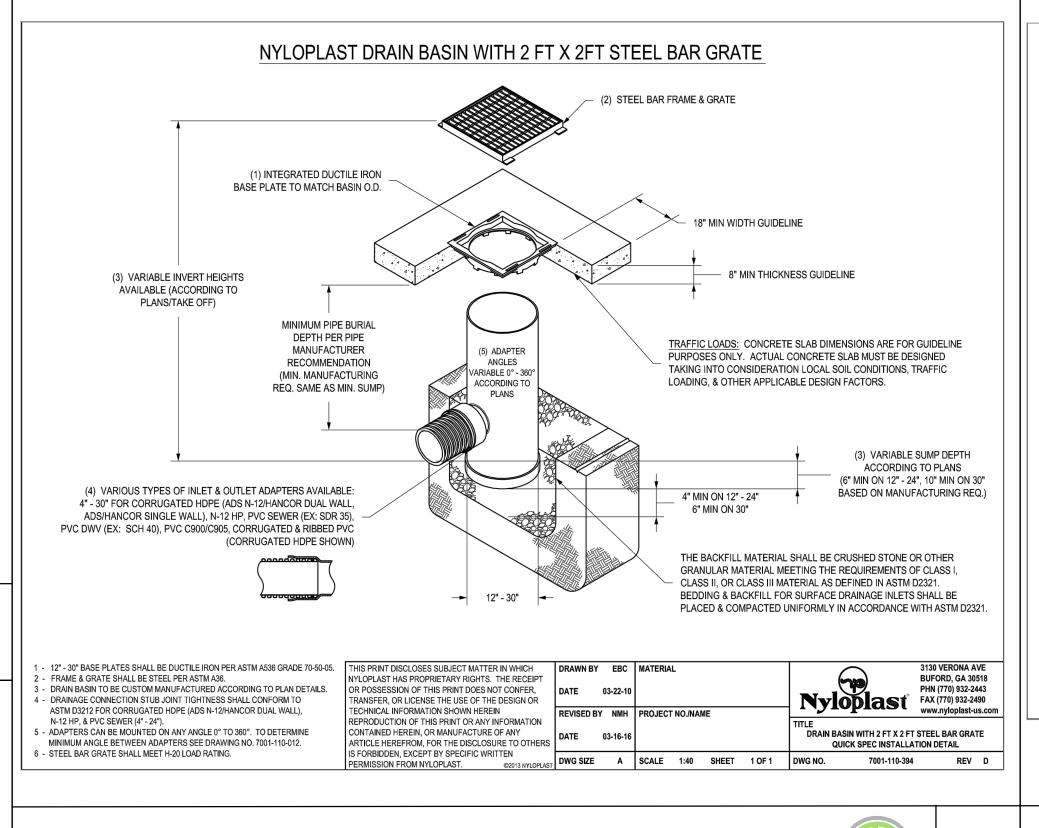

- SINGLE CURB & GUTTER

C=35.92

← C=35.97

 $\sim$  C=36.66

− C=36.77

5'X6' LANDING S=2% MAX IN ANY DIRECTION

15

₩ ₩

12:1

\_\_ C=36.62

12:1

C=34.92 ¬

C=34.87 —


MAJOR RAMP

C=35.81 —

C=35.76 —

C=34.82 —

TC=34.70C=34.20

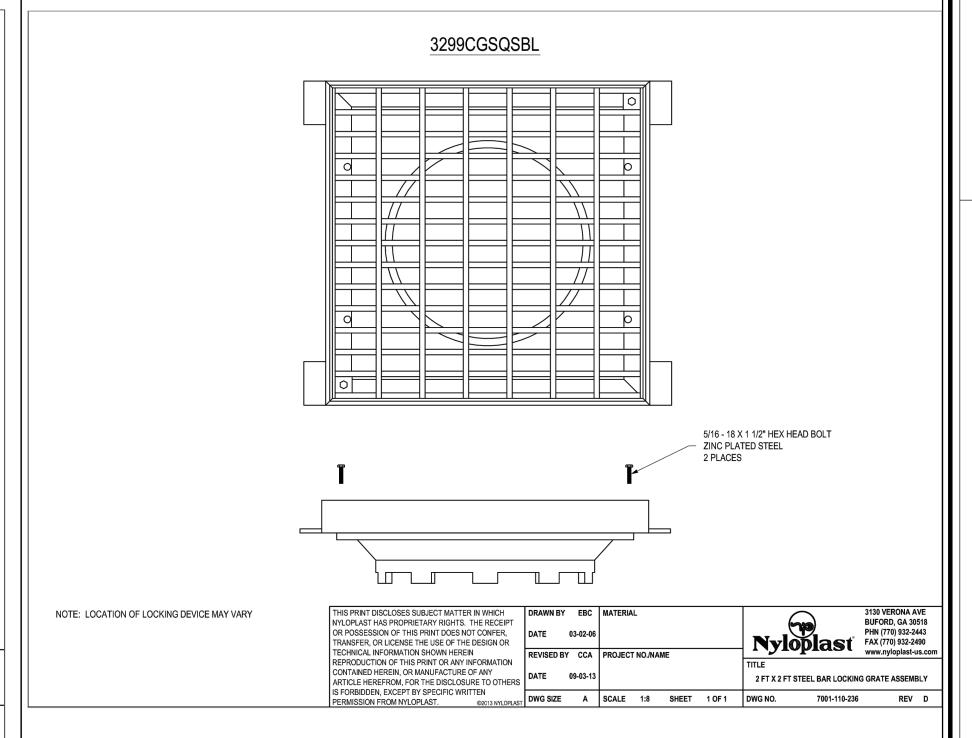





16

14

PROJ. MGR. — AF 01/21/2022

9 OF 11

11 1/2" 1/2" FILL BRICK LEDGE W/ HIGH STRENGTH 1/2" EXP. JT. — NÓN-SHRINK GROUT PAVING RE: CIVIL REFER TO STRUCTURAL PLAN FOR DD'L INFO AND DIMENSIONS NOT SHOWN. 1'-0"

TURNDOWN SIDEWALK - TYPE 2





SUSTAINABILITY ENGINEERING GROUP



01/18/2022

01/21/2022

ISSUED FOR: DRB REVISION NO.:

DATE: JOB NO.: 210907

**GRADING AND DRAINAGE DETAILS** 

C3.11










PROJECT WHATABURGUER NM SEC ALAMEDA BLVD NE	c SAN PEDRO AVE NE	OCATION 6100 ALAMEDA BLVD NE	ALBUQUERQUE, NM
	ళ	)     <b>61</b>	4
DRAWN		GA	12/08/202
1			

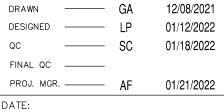


01/21/2022 ISSUED FOR: DRB

REVISION NO .: DATE: JOB NO.: 210907

SHEET TITLE: SITE CROSS SECTIONS


C3.20 10 OF 11

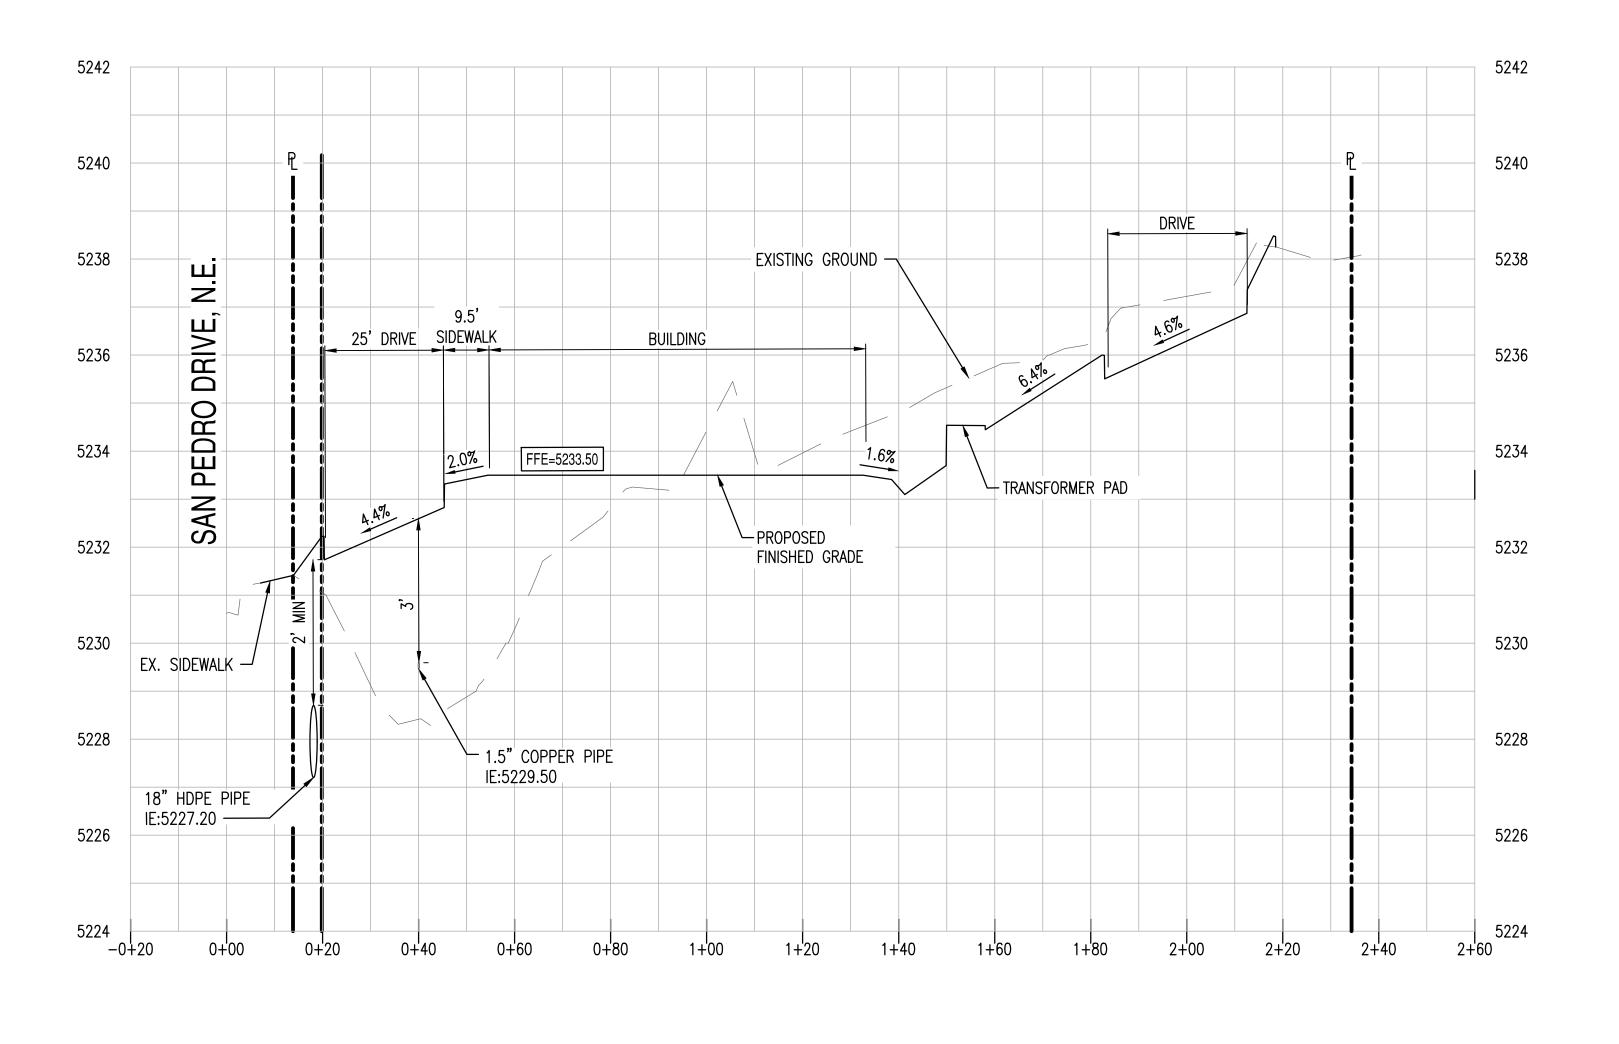

SECTION A-A C3.00 HORIZONTAL SCALE: 1" = 20' VERTICAL SCALE: 1" = 2'

SECTION B-B C3.00

HORIZONTAL SCALE: 1" = 20' VERTICAL SCALE: 1" = 2'

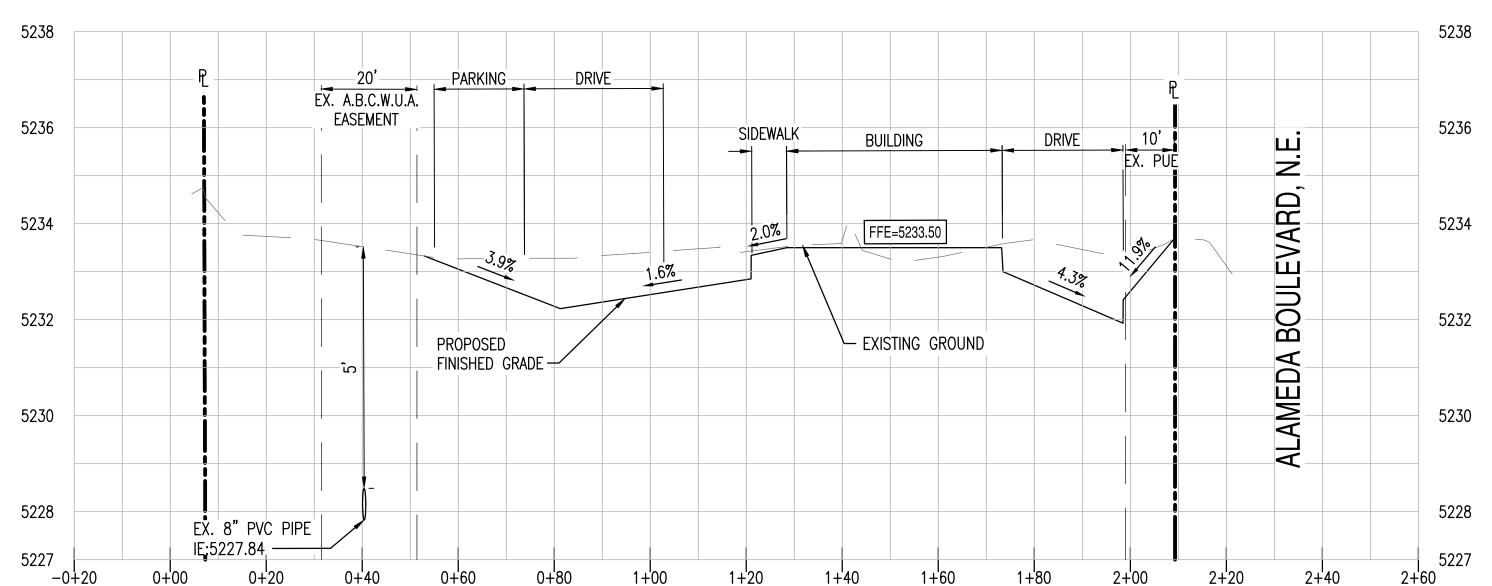

2+20 1+'00 2+'00